



BY LAND DEVELOPMENT
INITIALS *[Signature]*
APR 04 2017

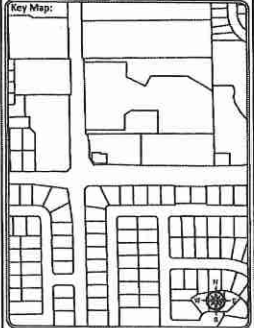


Sheet Title:
Design
Function:
Make ready Task:
FDH Placement



- NOTES:**
- 500 INSTALL 884F FDH ON CONCRETE PAD WITH 2x BOLLARDS. SEE DETAIL 'C' SHEET 500
 - 501 STUB 2-100mm DUCTS 0.5m ABOVE FINISHED GRADE
 - 502 INSTALL (2) 100mm DBII PVC CONDUIT L= 4.0 m. SEE DETAIL 'B' SHEET 500
 - 503 CORE FOR 2-100mm CONDUIT IN TELUS MH-243 SEE DETAIL 'A' SHEET 500

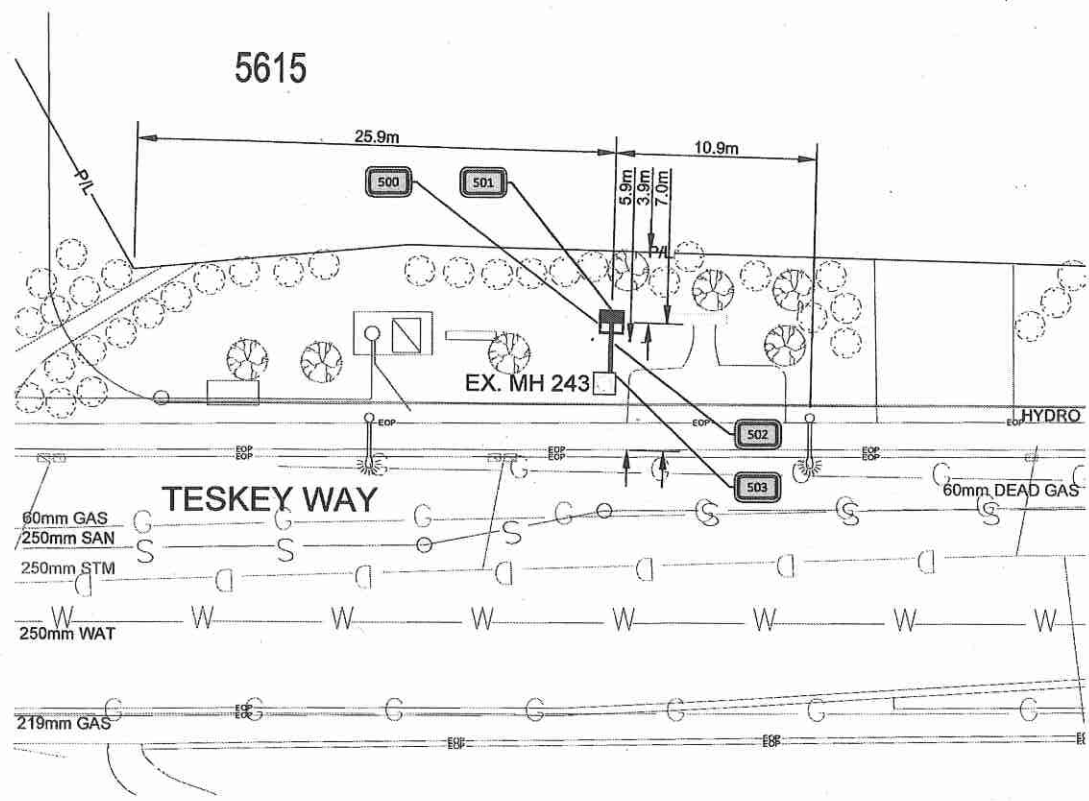

PLAN VIEW
HORIZONTAL SCALE: 1 : 250

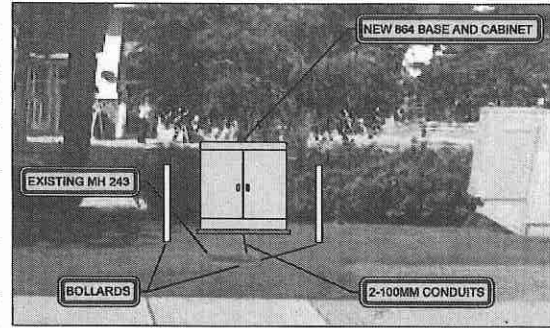

5615 TESKEY WAY
FDH - SITE PLAN
N.T.S.

CAUTION:
GAS FACILITIES IN AREA
LOCATE AND EXPOSE
PRIOR TO COMMENCING WORK

METHOD OF PLACEMENT
VIA OPEN TRENCH UNLESS
OTHERWISE NOTED

LOCATE AND PROTECT ALL
OTHER UTILITIES IN FIELD

ALL MEASUREMENTS ARE IN
METERS UNLESS NOTED

BC ONE CALL
CALL BEFORE YOU DIG
1-800-485-5050
OR BY CHANGING ONE
YOURSELF AREA 604-660-0000
CALL AT LEAST 48 HRS BEFORE DIG
EXPOSE THE PLAN TO US


Client:
TELUS

Prepared By:
FAFL
SUITE 200 - 7485 130 ST
Surrey BC V3W 1H8

Rev	Date	Notes	QC
-	-	-	-
-	-	-	-
-	-	-	-
-	-	-	-
-	-	-	-


IFP: March 16 2017
DRAWN BY: IEC: April 2017
DESIGNED BY: KADTEC SYSTEMS

Proprietary Information
Not for disclosure except under written agreement

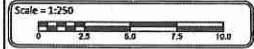

Project:
Falcon 2017
SRDS 3033A - 2625510
Sardis, BC

File Name:
C010 Route
SRDS 3033A
Network Number: 2625510 Sheet Number: 600

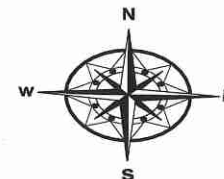


Date: May 11, 2017 **Author:** Katrina Seymour 604-444-3732 ext.250 **Project:** SRDS-3033A-2625510
Universal Flagging: 170-8061 Lougheed Hwy, Burnaby, BC V5A 1W9 **Office:** 604-444-3732 **Dwg:** 001

Comments:







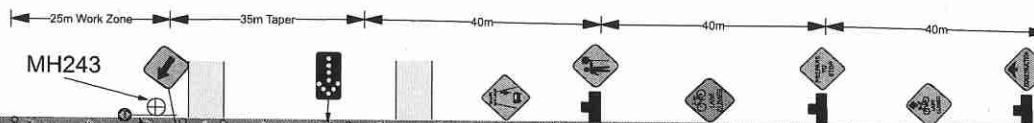

Telus
 Sandie Brust 778-791-1015

City of Chilliwack
 Job location: 5615 Teskey Way
 Closure description: West bound lane closure
 Tentative date and hours: May 29-June 7, 2017
 Job description: Civil construction - New conduit and pad construction for fibre distribution hub cabinet

Advanced Warning Sign distances may be shortened due to Urban block length



Legend

-  Bollard
-  Arrowboard (Single)
-  Work Area
-  Sign Stand
-  Flagger Ahead C-001-1
-  Prepare to Stop C-029
-  Construction AHEAD ARROW C-018-1A
-  Lane Closure Arrow - Left symbol C-053
-  flagger
-  Object Group
-  B-C-002